## PROJECT DESCRIPTION

I. GENERAL THIS PROJECT INVOLVES INSTALLATION OF APS/CPS PEDESTRIAN EQUIPMENT ON THE NORTH, SOUTH, AND WEST LEGS OF THE INTERSECTION OF MD 28 (KEY WEST AVENUE) AT OMEGA DRIVE AND MEDICAL CENTER DRIVE IN MONTGOMERY COUNTY. MD 28 IS ASSUMED TO RUN IN AN EAST-WEST DIRECTION.

II. INTERSECTION OPERATION THIS INTERSECTION OPERATES IN A NEMA SIX-PHASE SEMI-TRAFFIC-ACTUATED MODE. THERE ARE EXCLUSIVE LEFT-TURN PHASES FOR EASTBOUND AND WESTBOUND MD 28. THE OMEGA DRIVE AND MEDICAL CENTER DRIVE APPROACHES OPERATE CONCURRENTLY. AN ALTERNATE PEDESTRIAN PHASE ACROSS THE WEST LEG OF THE INTERSECTION IS PROVIDED. CONCURRENT PEDESTRIAN PHASES ARE PROVIDED ON THE NORTH AND SOUTH LEGS.

III. PEDESTRIAN OPERATION NAVIGATOR AUDIBLE PEDESTRIAN PUSHBUTTONS TO CROSS THE NORTH, SOUTH, AND WEST LEGS OF THE INTERSECTION ARE TO BE PROVIDED. WHEN THE PEDESTRIAN LOCATES AND PRESSES THE PUSHBUTTON FOR AN EXTENDED TIME, THE PUSHBUTTON UNIT WILL ANNOUNCE THE FOLLOWING MESSAGE:

NORTH: "WAIT TO CROSS OMEGA AT KEY WEST, WAIT." SOUTH: "WAIT TO CROSS MEDICAL CENTER AT KEY WEST, WAIT." WEST: "WAIT TO CROSS KEY WEST AT OMEGA/MEDICAL CENTER, WAIT."

WHEN THE WALK PHASE BEGINS, THE MESSAGE WILL BE A RAPID TICK WHICH WILL LAST FOR THE DURATION OF THE WALK PHASE.

## CONTACT PERSONS

THE CONTACT PERSONS FOR THIS PROJECT ARE AS FOLLOWS:

DISTRICT 3

MS. ANYESHA MODKHERJEE (MD) ASSISTANT DISTRICT ENGINEER - TRAFFIC 301-513-7404/301-513-7358

MR. VICTOR GRAFTON DISTRICT ENGINEER - UTILITIES 301-513-7350

MR. DUANE BERNARD ASSISTANT DISTRICT ENGINEER - CONSTRUCTION 301-513-7385

MR. THOMAS FOUNTAIN ASSISTANT DISTRICT ENGINEER - MAINTENANCE 301-513-7304

MONTGOMERY COUNTY

MR. ROBERT RICKETTS TECHNICAL CENTER SUPERVISOR PHONE NUMBER 240-876-3681

MR. KAMAL HAMUD MONTGOMERY COUNTY-TRAFFIC ENGINEERING PHONE NUMBER 301-777-8761

OFFICE OF TRAFFIC AND SAFETY

MS. CORREN JOHNSON CHIEF, TRAFFIC OPERATIONS 410-787-7630

MR. ROBERT SNYDER ASSISTANT DIVISION CHIEF, TRAFFIC OPERATIONS 410-787-7630

CHEIF SIGNAL OPERATIONS 410-787-7650 MR. EUGENE BAILEY

CHIEF SIGN OPERATIONS

MR. ED RODENHIZER

410-787-7668

410-787-7670 MR. MIKE STOCKER SUPPLY OFFICER IV (SIGNAL SHOP WAREHOUSE)

## EQUIPMENT LIST

MAINTENANCE OF TRAFFIC WILL BE HANDLED BY THE CONTRACTOR UTILIZING THE FOLLOWING STANDARD PLATES FOR TRAFFIC CONTROL: MD 104.03-11. MD 104.04-13 THROUGH MD 104.04-16.

> A. EQUIPMENT TO BE FURNISHED BY STATE HIGHWAY ADMINISTRATION ITEM NO. QUANTITY UNIT DESCRIPTION

900000 SHEET ALUMINUM MAST ARM/POLE MOUNTED SIGN M1-5(6) (36"X72"), 2 EA. 36 SF M1-5(6) (24"X48"), 2 EA. 16 SF 900000 SHEET ALUMINUM GROUND MOUNTED SIGN W11-2 (36"X36"), 6 EA. 54 SF W16-7p(L) (24"X12"), 3 EA, 6 SF W16-7p(R) (24"X12"), 3 EA, 6 SF

B. EQUIPMENT TO BE FURNISHED AND/OR INSTALLED BY CONTRACTOR ITEM NO. QUANTITY UNIT DESCRIPTION

100000	1	EΑ	MAINTENANCE OF TRAFFIC (PER INTERSECTION)
201032	40	CY	CLASS 2 EXCAVATION
203030	3	CY	TEST PIT EXCAVATION
500000	600	LF	10 INCH WHITE PREFORMED THERMOPLASTIC PAVEMENT MARKING LINES
585617	160	LF	5 INCH WHITE PREFORMED THERMOPLASTIC PAVEMENT MARKING LINES
585621	1690	LF	12 INCH WHITE PREFORMED THERMOPLASTIC PAVEMENT MARKING LINES
585625	10	LF	24 INCH WHITE PREFORMED THERMOPLASTIC PAVEMENT MARKING LINES
585700	1630	LF	REMOVAL OF EXISTING PAVEMENT MARKING LINES, ANY WIDTH
600000	240	ĹF	TYPE A COMBINATION CURB AND GUTTER ANY HEIGHT OR DEPTH
600000	190	LF	TYPE A CURB ANY HEIGHT OR DEPTH
655105	1260	SF	5 INCH CONCRETE SIDEWALK
655120	130	SF	DETECTABLE WARNING SURFACE FOR CURB RAMPS
800000	1	EA	2-WIRE APS CENTRAL CONTROL UNIT
800000	3	EΑ	ADJUST HANDHOLE TO GRADE AND REPLACE FRAME AND COVER
800000	6	EA	AUDIBLE/TACTILE PEDESTRIAN PUSHBUTTON STATION AND SIGNS
800000	6	EA	16 INCH LED COUNTDOWN PEDESTRIAN SIGNAL HEAD
800000	6	EΑ	5 FOOT OR 10 FOOT PEDESTAL POLE WITH BREAKAWAY COUPLINGS, FOUNDATION & GROUND ROD
800000	1	EA	REMOVE & DISPOSE OF EXISTING SIGNAL EQUIPMENT (PER SIGNALIZED INTERSECTION LOCATION)
800000	80	LF	UP TO 4 INCH SCHEDULE 80 RIGID PVC CONDUIT-TRENCHED
800000	105	LF	WOOD SIGN SUPPORTS UP TO 4 INCH X 6 INCH
800000	118	SF	INSTALL OVERHEAD OR GROUND MOUNTED SIGN (INCLUDING ALL HARDWARE)
800000	1	EA	THIRD PARTY CONCRETE TESTING (PER INTERSECTION)
802501	350	LF	NO. 6 AWG STRANDED BARE COPPER GROUND WIRE
861105	1190	LF	ELECTRICAL CABLE - 2 CONDUCTOR (NO. 14 AWG)
061107	1220	1 –	ELECTRICAL PLANTS OF THE PROPERTY OF THE PROPE

ELECTRICAL CABLE - 5 CONDUCTOR (NO. 14 AWG)


C. ALL MATERIALS TO BE REMOVED BY THE CONTRACTOR SHALL BECOME THE PROPERTY OF THE CONTRACTOR.

PHASING CHART

2 3 4 5 6 7 8 9 10 11 12 13 14 15 16 17 18 19 20 21 

PHASE 1 & 5	4-G-	-   <b>∢</b> -G−	- R	R	4-G-	-G-	- <b>∢</b> -G−	R	R	R	R	R	R	R	R	DW	DW	DW	DW	DW	Tow	$T^{\perp}\Delta$
I & 5 CHANGE	CON	CONTROLLER MAY CHANGE TO PHASE 1 & 6 OP PHASE 2 & 5 OP PHASE 2 & 6																				
PHASE 1 & 6		- d-R-	1	R		ì	4-G−	T	G	R	R	R	R	R	R	DW	DW	DW	DW	DW	DW	<u> </u>
1 & 6 CHANGE	4-R−	-   4-R-	R	R	<b>4</b> -Y−	<b>4-Y</b> ~	<b>4</b> -Y−	- Y	Y	R	R	R	R	R	R	DW	DW	DW	DW	DW	DW	┤ ~ ╭
PHASE 2 & 5	<b>4-G</b> −	<b></b>	G	G	4-R−	<b>4-R−</b>	4-R-	R	R	R	R	R	R	R	R	DW	DW	DW	DW	DW	DW	1. Y V
2 & 5 CHANGE	<b>4</b> Y−	<b>4</b> -Y−	Υ	Υ	4-R−	4-R−	4-R−	R	R	R	R	R	R	R	R	DW	DW	DW	DW	DW	DW	
PHASE 2 & 6	4-R−	4-R−	G	G	<b>4-R−</b>	φ-R-	4-R−	G	G	R	R	R	R	R	R	wĸ	wĸ	WK	WK	<del></del>	DW	,i,
PED CLEAR	4-R−	4-R-	G	G	4-R−	4-R−	4-R−	G	G	R	R	R	R	R	R	FL/DW	FL/DW	/FL/DW	<del></del>		DW	
2 & 6 CHANGE	4-R-	4-R-	Y	Υ	4∙R−	4-R−	∢-R-	Υ	Υ	R	R	R	R	R	R	DW	DW	DW	DW	DW	-	E
PHASE 4 & 8	4-R−	4-R−	R	R	4-R-	4-R−	4-R-	R	R	G	G	G	G	G	G	DW	DW	DW	DW	DW	DW	1 7
4 & 8 CHANGE	4-R—	4-R−	R	R	4-R−	<b>4-R</b> −	4-R−	R	R	Y	Υ	Y	Y	Y	Υ	DW	DW	DW	DW	DW	DW	4 I [
PHASE ALT. 4 & 8	4-R-	⊄R-	R	R	4-R−	<b>∢-R</b> —	4-R−	R	R	G	G	G	G	G	G	DW	DW	DW	DW	WK	WK	۱ ۷ ۲
PED CLEAR	4-R−	4-R—	R	R	4-R−	<b>4-R</b> −	4-R-	R	R	G	G	G	G	G	G	DW	DW	DW		FL/DW	-	/?  <i>4</i>
ALT. 4 & 8 CHANGE	4-R—	4-R	R	R	4-R~	4-R−	4-R—	R	R	Υ	Υ	Υ	Υ	Y	Υ	DW	DW	DW	DW	DW	DW	₩
FLASHING OPERATION	FLAR	FL⁄4R	FL/Y	FL/Y-	FL∕⊴R	FL⁄4R-	FL⁄4R	FL/Y	FL/Y	FL/R	FL/R	FL/R	FL/R	FL/R	FL/R	DARK		DARK		<del></del>		- - - - - - - - - - -

WIRING DIAGRAM

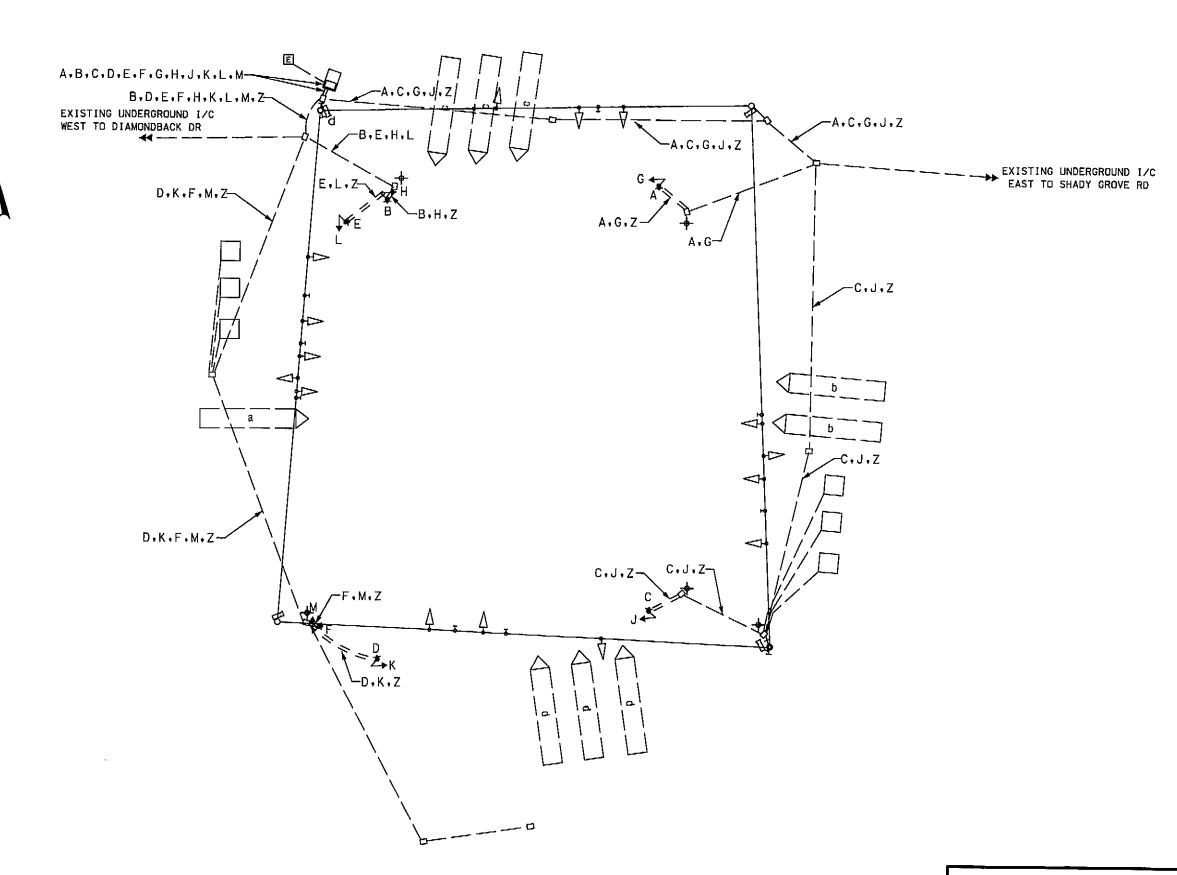

WIRING KEY A,B,C,D,E,F - ELECTRICAL CABLE - 2 CONDUCTOR (NO. 14 AWG) G.H.J.L.K.M - ELECTRICAL CABLE - 5 CONDUCTOR (NO. 14 AWG) Z - NO. 6 AWG STRANDED BARE COPPER GROUND WIRE.

STATE OF MARYLAND DEPARTMENT OF TRANSPORTATION STATE HIGHWAY ADMINISTRATION OFFICE OF TRAFFIC & SAFETY TRAFFIC ENGINEERING DESIGN DIVISION

MD 28 (KEY WEST AVENUE) AT OMEGA DRIVE/MEDICAL CENTER DRIVE

ROCKVILLE, MARYLAND **GENERAL INFORMATION SHEET** 

SCALE N.T.S.	ADVERTISED DATE_!	MARCH 2013 CC	ONTRACT NO. XY1515185
	AMH/JVB JVB	_	MONTGOMERY 15R02800.99
CHECKED BY	JFL	TIMS NO.	L735
F.A.P. NO		TOD NO	
TS NO.4057F GI	DRAWING SG-3	OF 3	SHEET NO. 9 OF 24

PLOTTED: "10:25 AM on Tuesday, April 02, 2013" FILE: M:\2009\01090619.87\drawings\pSG-P003\_MD28GI.dgn

SCIENTISTS TECHNOLOGIES Fax: (410) 316-7818

CONSTRUCTION MANAGERS

861107

1220

936 RIDGEBROOK ROAD Sparks, Maryland 21152

TELEPHONE: (410) 316-7800

LF